

IRRIGATION

DURING THE ESTABLISHMENT PERIOD.

PLANT QUANTITIES SHOWN ARE FOR PERMITTING PURPOSES ONLY. IT IS THE RESPONSIBILITY OF THE CONTRACTOR TO CONFIRM ALL QUANTITIES SHOWN ON THE PLAN.

WATER FOR TREES SHALL BE PROVIDED BY WATER BAGS. BAGS SHALL BE CONSTRUCTED OF

POLYETHYLENE AND HAVE A MANUFACTURER RECOMMENDED APPLICATION METHOD FOR TREES OF

THE SIZE SPECIFIED. CONTRACTOR SHALL BE RESPONSIBLE FOR THE WATERING OF THE TREES

ALL PLANT MATERIAL TO BE FLORIDA NO.1 OR BETTER, GRADED IN ACCORDANCE WITH THE STATE OF FLORIDA DEPARTMENT OF AGRICULTURE, DIVISION OF PLANT INDUSTRY'S 'GRADES AND STANDARDS FOR NURSERY PLANTS', CURRENT EDITION AT THE TIME PLANS ARE ISSUED.

PLANT MATERIAL

ALL DISTURBED AND UNPAVED AREAS TO BE GRASSED WITH SOD THAT IS FREE OF NOXIOUS WEEDS INCLUDING TROPICAL SODA APPLE. SEE CIVIL SITE PLANS FOR ADDITIONAL RELATED INFORMATION. PIN ALL SODDED SLOPES STEEPER THAN 3:1.

<u>GRASSING</u>

LEADER SHOOTS AND MAIN STRUCTURAL LIMBS OF TREES SHALL NOT BE TOPPED OR PRUNED. TREES WILL BE STAKED AS NEEDED. GUYLINES WILL BE OF NON-SYNTHETIC BIODEGRADABLE MATERIAL.

NEW TREES OUTSIDE OF MULCHED LANDSCAPED BEDS WILL BE PROTECTED FROM MOWER AND STRING TRIMMER DAMAGE WITH 10" OF PLASTIC DRAIN TUBING.

ALL LANDSCAPED AREAS SHALL BE MULCHED WITH 3" THICKNESS OF MULCH. PINE STRAW MULCH SHALL BE USED IN ALL AREAS.

<u>GENERAL NOTES</u> ALL ASPHALT, LIMEROCK, AND CONSTRUCTION DEBRIS SHALL BE REMOVED FROM PLANTING BEDS AND SOD AREAS PRIOR TO LANDSCAPE INSTALLATION. IF ENCOUNTERED DURING CONSTRUCTION OR INSTALLATION, THESE SHALL BE EXCAVATED AND REMOVED FROM THE SITE. PLANTING DEPTH OF SOIL IN SUCH AREAS SHOULD BE AT LEAST 3'. IF FILL MUST BE ADDED, IT MUST BE FLORIDA CLEAN DEEP FILL (FREE OF WEED SEEDS) WITH pH 6.0 - 7.5.

1 TREE PLANTING DETAIL SCALE: N.T.S.

10" PLASTIC

DRAIN TUBING-

SLOPE SIDES OF

LOOSENED SOIL.

ROUND-TOPPED SOIL BERM 4"


HIGH X 8" WIDE ABOVE ROOT -

CONSTRUCTED AROUND THE

ROOT BALL. BERM SHALL BEGIN

BALL SURFACE SHALL BE

AT ROOT BALL PERIPHERY.

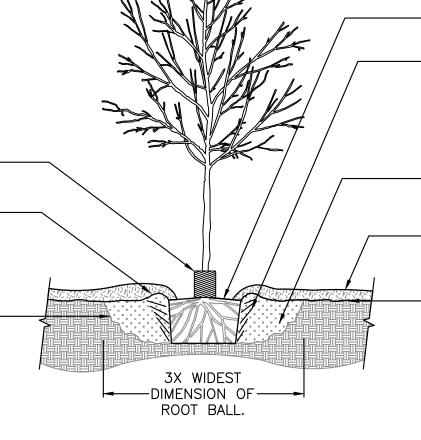


-FINISHED GRADE


-3" LAYER OF MULCH. NO MORE THAN 1" OF MULCH ON TOP OF ROOT BALL.


HAS BEEN BACKFILLED, POUR WATER AROUND THE ROOT BALL TO SETTLE THE SOIL. -LOOSENED SOIL. DIG AND TURN THE SOIL TO REDUCE COMPACTION TO THE AREA AND DEPTH SHOWN.

- TOP OF ROOT BALL SHALL BE FLUSH WITH FINISHED GRADE. - PRIOR TO MULCHING, LIGHTLY TAMP

SOIL AROUND THE ROOT BALL IN 6" LIFTS TO BRACE TREE. DO NOT OVER COMPACT. WHEN THE PLANTING HOLE

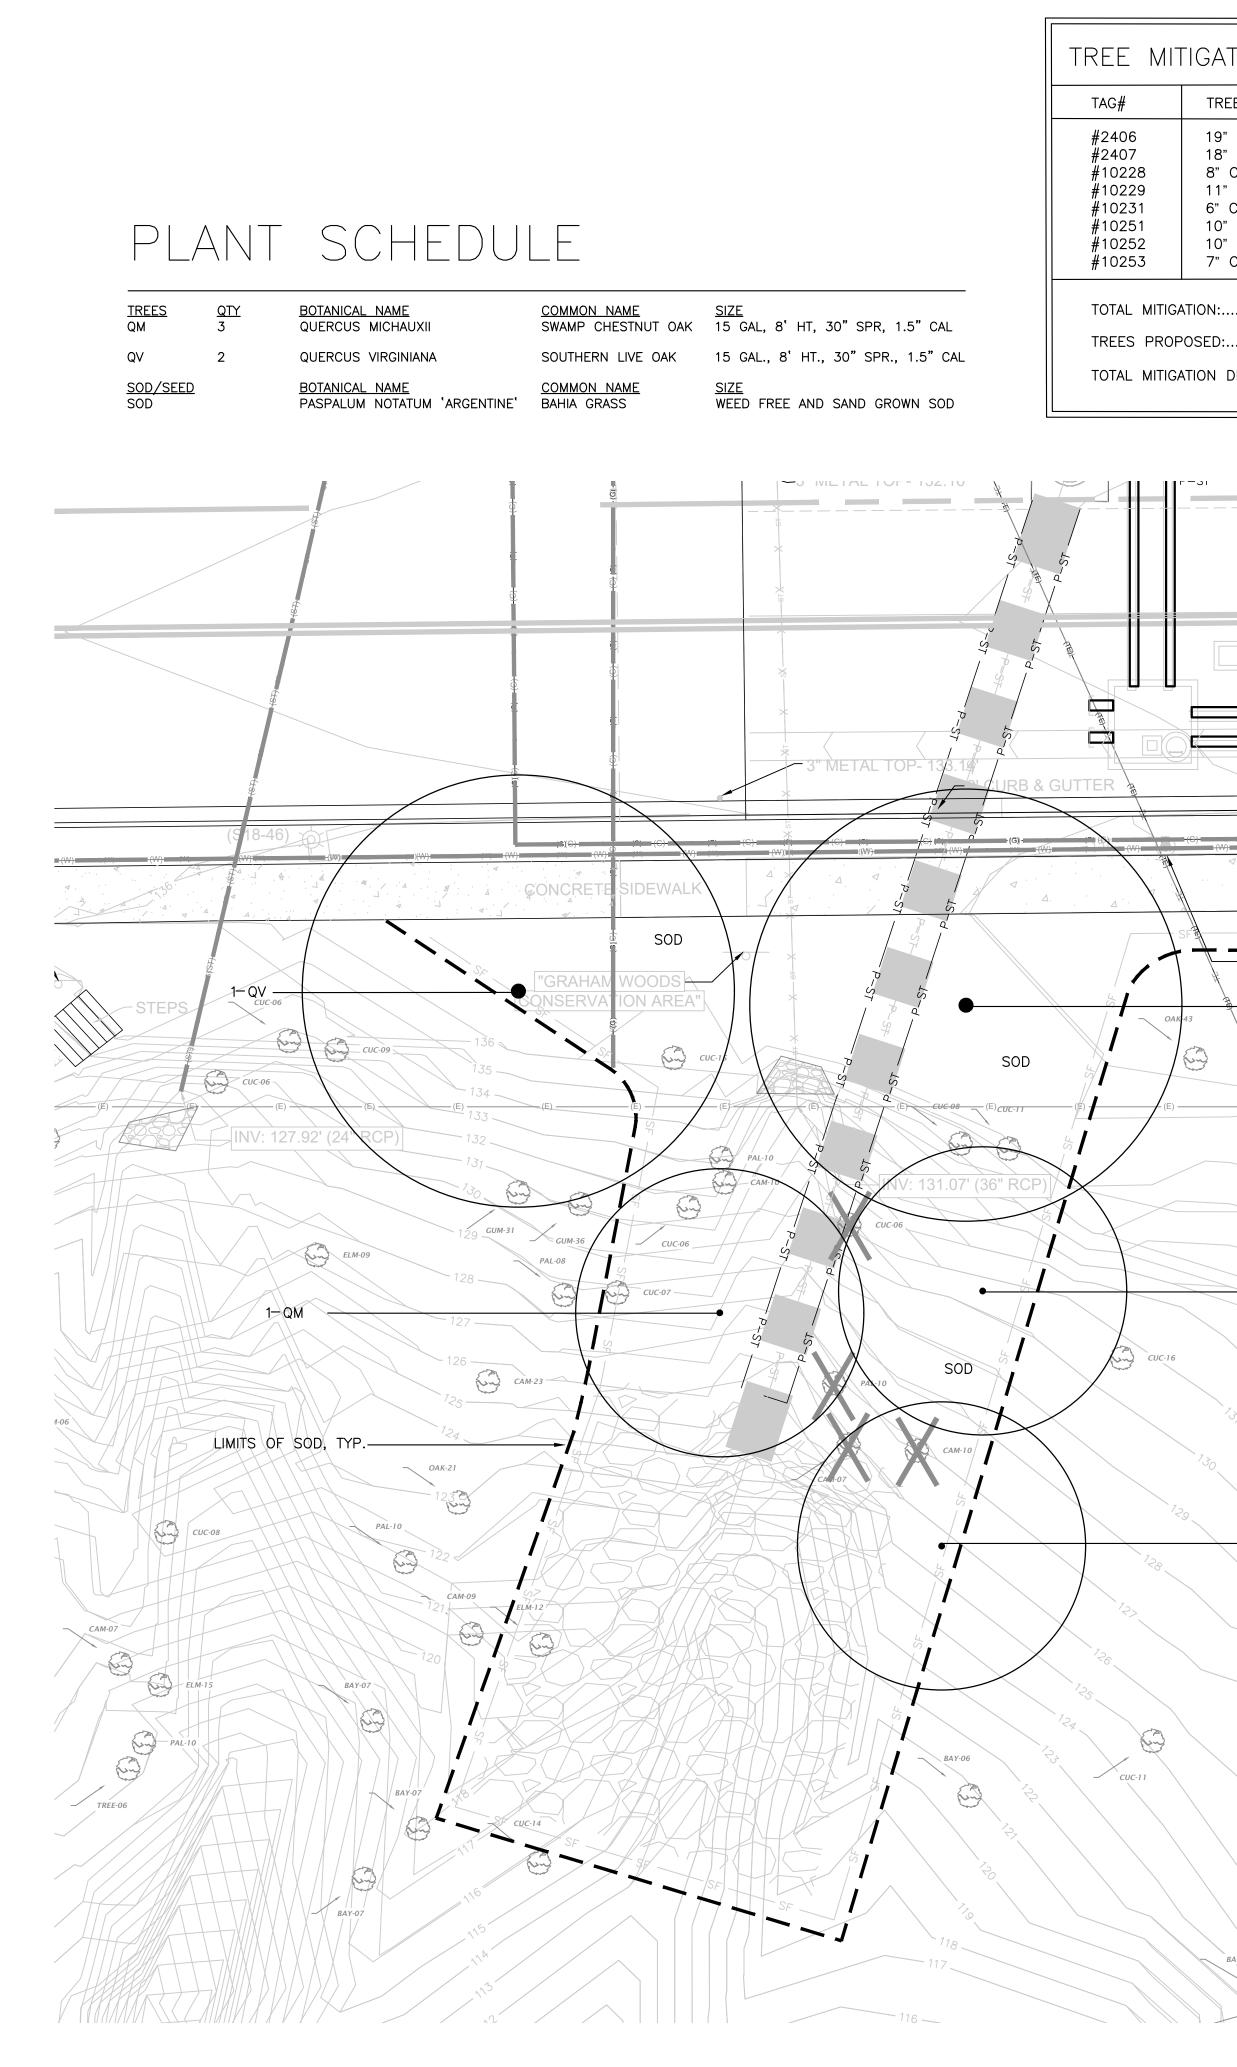

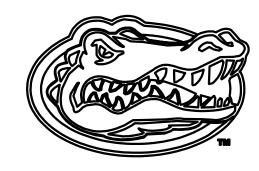

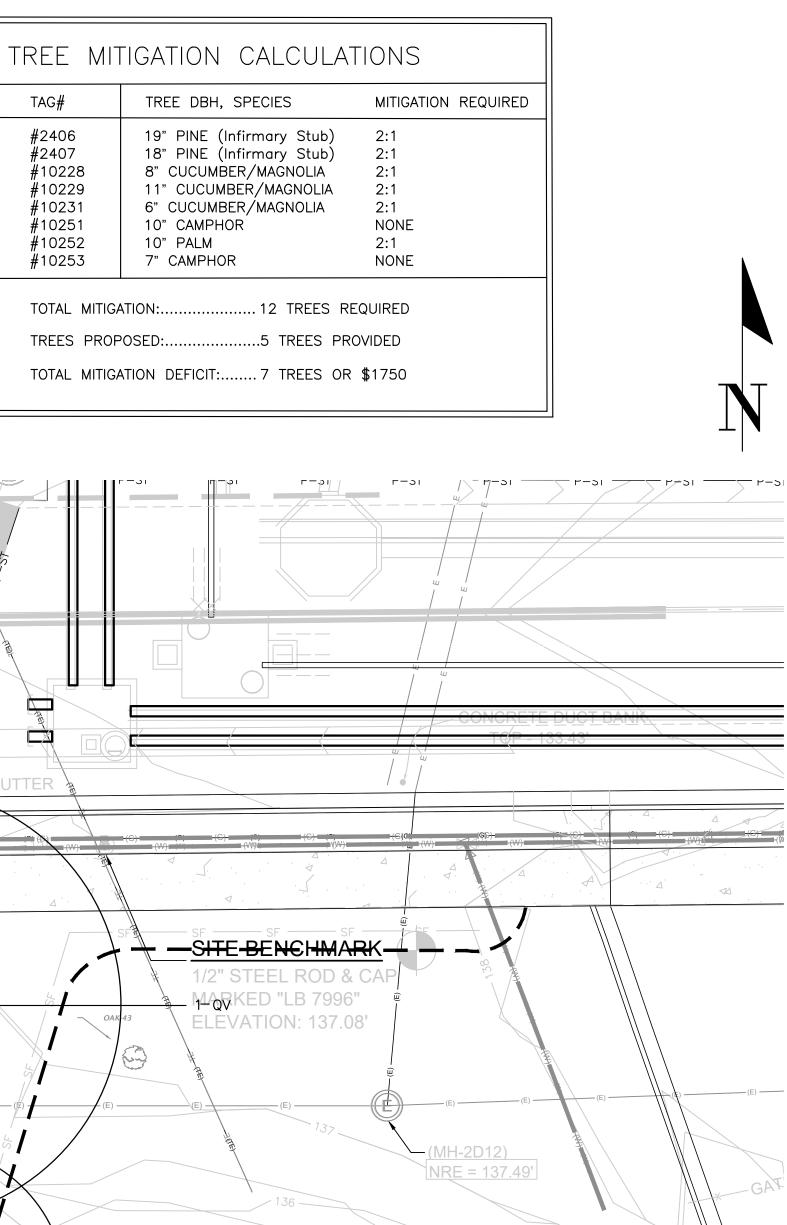

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Project University of Florida Football Training Center Off-Site Utility Package 2150 Stadium Road Gainesville, Florida Prepared For The University Athletic Association University of Florida Planning, Design & Construction

Gainesville, Florida 32611-5050



Hellmuth, Obata & Kassabaum, Inc. 300 West 22nd Street Kansas City, MO 64108 USA t +1 816 472 3360 f +1 816 472 2100

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GRAPHIC SCALE

Civil Engineer & Landscape Architect CA-5075, LC26000564 11801 Research Drive Alachua, FL 32615 Moses Engineering Mechanical & Electrical Engineer 2209 NW 40th Terrace, #A Gainesville, FL 32605

No.	Description	Date
	ASD SUBMITTAL	2019 November 2
	60% SUBMITTAL	2020 February 10
	100% SUBMITTAL	2020 March 13
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Sheet Title